TYPICAL WINDOW & DOOR NOTE:

ALL EXTERIOR WINDOWS & DOORS TO BE

HURRICANE & PRESSURE RATED TO MEET DESI

HURRICANE & PRESSURE RATED TO MEET DESIGN
PRESSURES COMPLYING WITH SECTION 603 (ICC-600)
& SECTION R301.2(2). REFER TO STRUCT. DWGS.

GLASS IN HANDRAILS & GUARDRAIL NOTE:
ALL GLASS HANDRAILS, GUARDRAILS & STRUCT.
BALUSTERS TO MEET SECTION 308.4 & 308.4.4
IRC2009. GUARDRAIL HEIGHT TO BE 36"(MIN) ABOVE
FIN. FLOOR SURFACE (IRC2009 R311 & R312)

HANDRAILS & GUARDRAIL NOTE:

ALL STAIR HANDRAILS & GUARDRAILS TO MEET REQUIREMENTS AS PER SECTION 311 & 312 IRC2009. GUARDRAIL HEIGHT TO BE 36"(MIN) ABOVE FIN. FLOOR SURFACE. (R312.2 & R312.3 OPENINGS

STAIR NOTE: (TYPICAL)

ALL STAIR RISE & RUN RATIO'S SHALL BE IN

ACCORDANCE WITH SECTION 311 IRC2009. MAX. RISE

@ 7 3/4" & MIN. TREAD @ 10" AS PER R311.7.4

A NOSING BETWEEN 3/4" & 1 1/4" SHALL BE

PROVIDED ON ALL TREADS LESS THAN 11" WIDTH

SMOKE DETECTOR / ALARM NOTE:

PROVIDE AC/DC SMOKE DETECTORS INSIDE & OUTSIDE EACH SLEEPING ROOM & TOP & BOTTOM OF STAIRS AS PER SECTION R314.1 THRU R314.3 IRC2009 REFER TO ELECT. DWGS.

CARBON MONOXIDE DETECTOR / ALARM NOTE:
PROVIDE CARBON MONOXIDE DETECTORS OUTSIDE
EACH SLEEPING ROOM IN GENERAL VICINITY AS PER
SECTION R315.1 IRC2009

HALLWAY NOTE: (TYPICAL)

REFER TO ELECT. DWGS.

THE MINIMUM HALLWAY WIDTH SHALL BE >36"
AS PER SECTION R311.6 IRC2009

LANDINGS AT EGRESS DOORS:

LANDINGS OR FLOOR AT THE REQUIRED EGRESS DOOR SHALL NOT BE MORE THAN 1-1/2" LOWER THAN TOP OF THRESHOLD AS PER R311.3.1 CIRC.


ROOF VENTILATION NOTE:


ALL ENCLOSED ATTICS & ENCLOSED RAFTER SPACES FORMED WITH CEILINGS APPLIED TO U/S OF RAFTER TO BE VENTILATED TO MEET SECTION R806 IRC2009 ATTIC AREA = 3000 SF (1/150) = 20 SF VENT

WASTE STACK VENT NOTE:

A STACK VENT SHALL BE INSTALLED FOR THE WASTE AS PER SECTION R3109.3 WITH SIZE NOT LESS THAN SIZE OF WASTE STACK. OFFSETS SHALL BE 6" ABOVE FLOOR LEVEL OF HIGHEST FIXTURE PER P3104.5

WINDOW & DOOR TURTLE FRIENDLY REQUIREMENTS:
EXTERIOR DOORS & WINDOWS TO MEET DOE DESIGN
STANDARDS. PROVIDE TINTED GLASS OR FILM WITH
A VISIBLE LIGHT TRANSMITTANCE OF 15% OR LESS
AS REQUIRED.

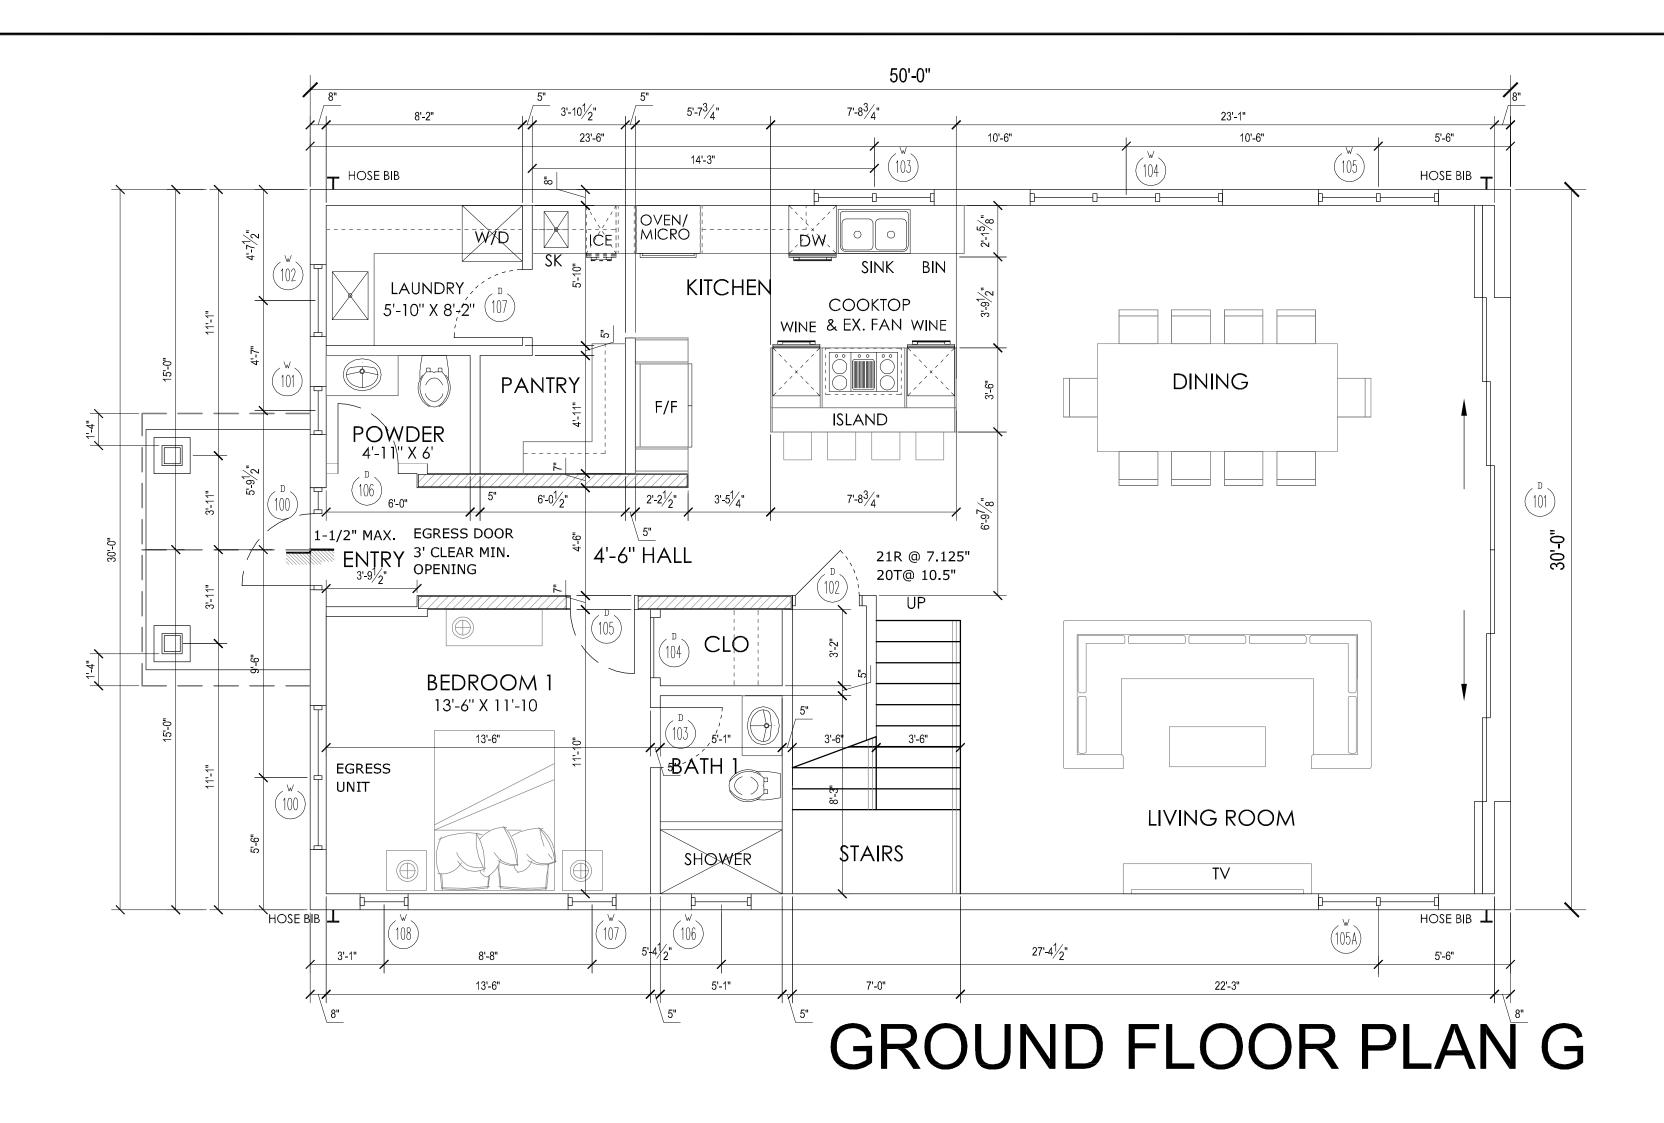

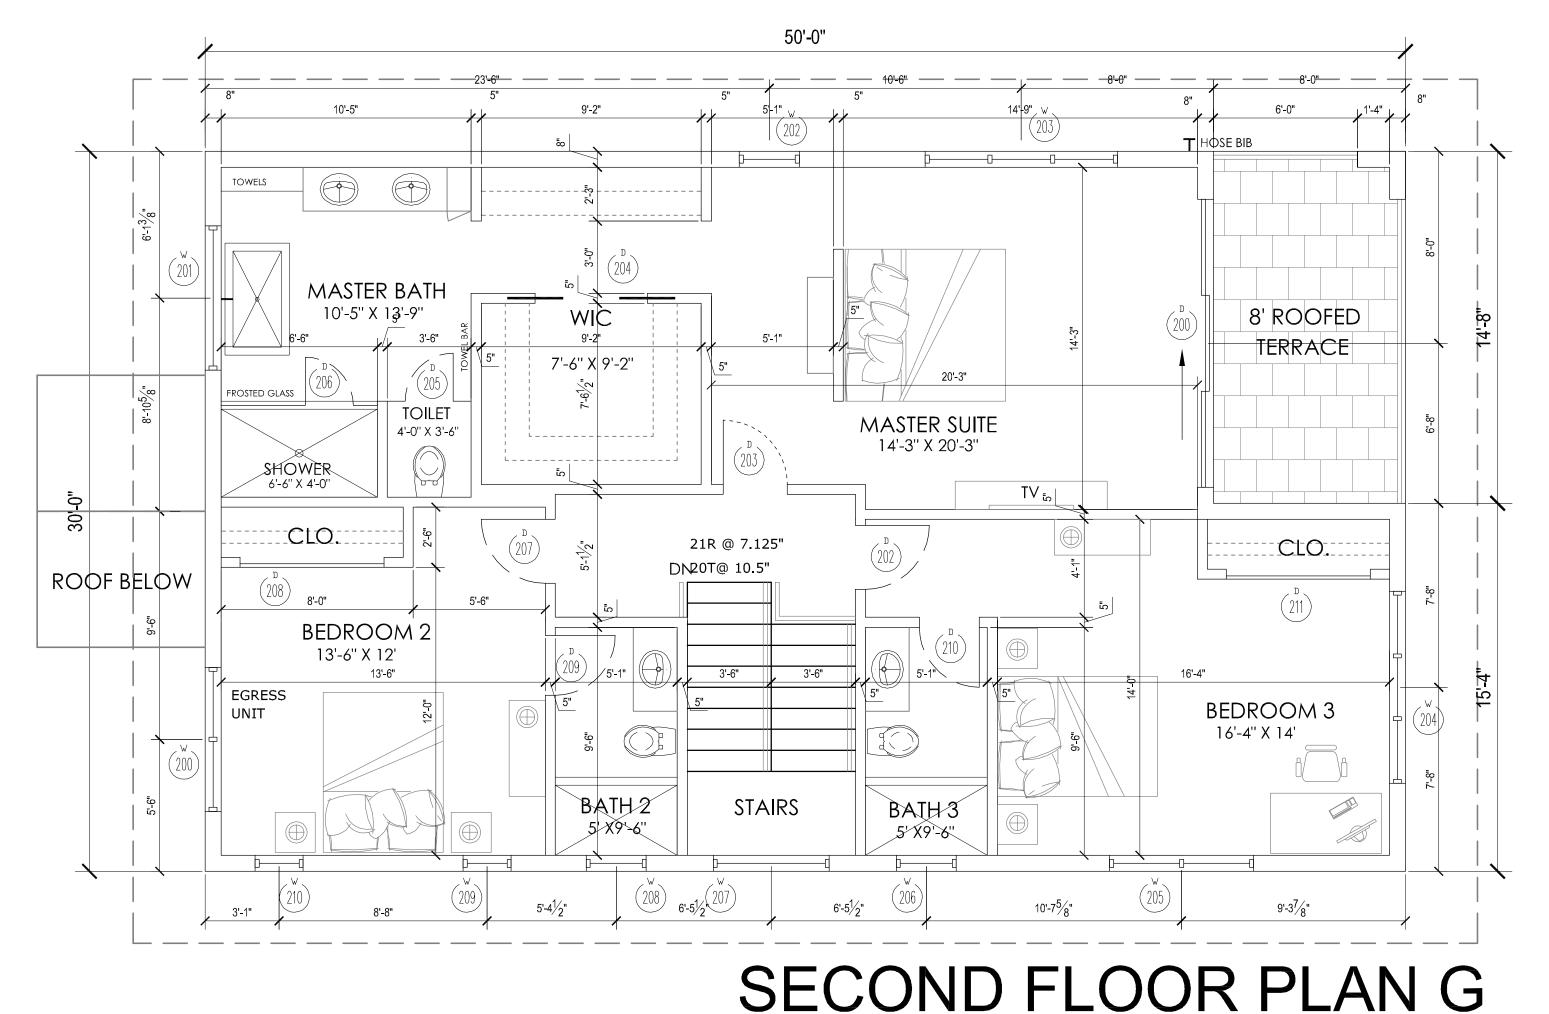


CONTRACTOR SHALL VERIFY ALL DIMENSIONS PRIOR TO CONSTRUCTION AND REPORT ANY DISCREPANCIES TO ARCHITECT.

- Written dimensions on these drawings have precedence
 over scale dimensions
- over scale almensions.

 Contractors shall verify and be responsible for all dimensions and conditions of the job. Architect shall be
- 3. All construction shall be in accordance with IRC 2009 and local codes having jurisdiction.
- 4. All plans, prints and designs are the property of the Architect and are not to be copied or reproduced or assigned to any third party without expressed written permission by Robert Towell Architect Ltd. © COPYRIGHT 2018

notified in writing of any variations or discrepancies from the dimensions, conditions and specifications shown by

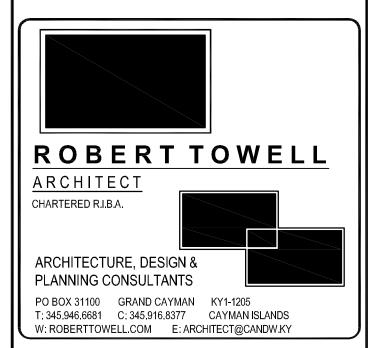

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<u>LEGEND</u>

6" OR 8" CONC. BLOCK WALL AS PER STRUCT.
DWGS. W/ 1/2" CEMENT RENDERING ON INTERIO
SIDE OF WALL & SKIM COAT FINE FINISH
PRIME & PAINT W/ 2 COATS PRATT & LAMBERT
PROVIDE 2" EIFS FINISH TO ALL EXTERIOR WALLS
WITH COLOR & TEXTURE AS APPROVED BY OWNE
PROVIDE 5.5" TIMBER BASEBOARDS ON ALL WALL
WITH PRIMED & PAINTED FINISH
INTERIOR STUD PARTITIONS

INTERIOR STUD PARTITIONS TO BE 5/8" GYP.
BOARD TO BOTH SIDES OF 3 5/8" METAL
STUDS @ 16" O.C. (UNLESS NOTED)
ALL WET & TILED WALL LOCATIONS TO
RECEIVE 1/2" CEMENT BACKING BOARD
ALL BEDROOM WALLS TO INCLUDE 4" BATT INSI
PROVIDE 5.5" TIMBER BASEBOARDS ON ALL WA
WITH PRIMED & PAINTED FINISH

INTERIOR CEILINGS

ALL CEILINGS TO BE 1/2" GYP. BOARD ON 7/8" METAL CEILING CHANNELS @ 16" OC.

ALL WET CEILING LOCATIONS TO RECEIVE 5/8"

CEMENT BACKING BOARD W/ PAINTED FINISH

- DOOR NUMBER
 (REFER TO DOOR SCHEDULE)
- (102) WINDOW NUMBER (REFER TO WINDOW SCHEDULE)
- 4" CHANGE IN FLOOR LEVEL (TYPICALLY 4" UNLESS NOTED)

ISSUED TO CLIENT & ENGINEER

REVISION

V		
-		
	I hereby certify that all dimensions shown on this plan are correct:	
	Robert Towell	
•	Signed	
	ROBERT TOWELL ARCHITECT LTD. BAYSHORE MALL 30 SOUTH CHURCH, 2ND FLOOR - UNIT 7A P.O. BOX 31100, GRAND CAYMAN CAYMAN ISLANDS - KY1-1205	
STRUCT:		
MECH:	-	
ELECT:	-	

PLUMB: -			
PROJECT:			
OCEANS 9 - BEACH HOUSES BOATSWAIN BAY - WEST BAY			
DRAWING:			
FLOOR PLAN G - UNITS 7, 8 & 9			
DRAWN BY:	DATE: SEPT 2022		
CHECKED BY:	SCALE: 1/4" = 1'-0"		
ISSUED FOR:	BLOCK& PARCEL:		
PERMIT	1C 271		
PROJECT NO.	DRAWING NO. A-5-G	REV. NO.	